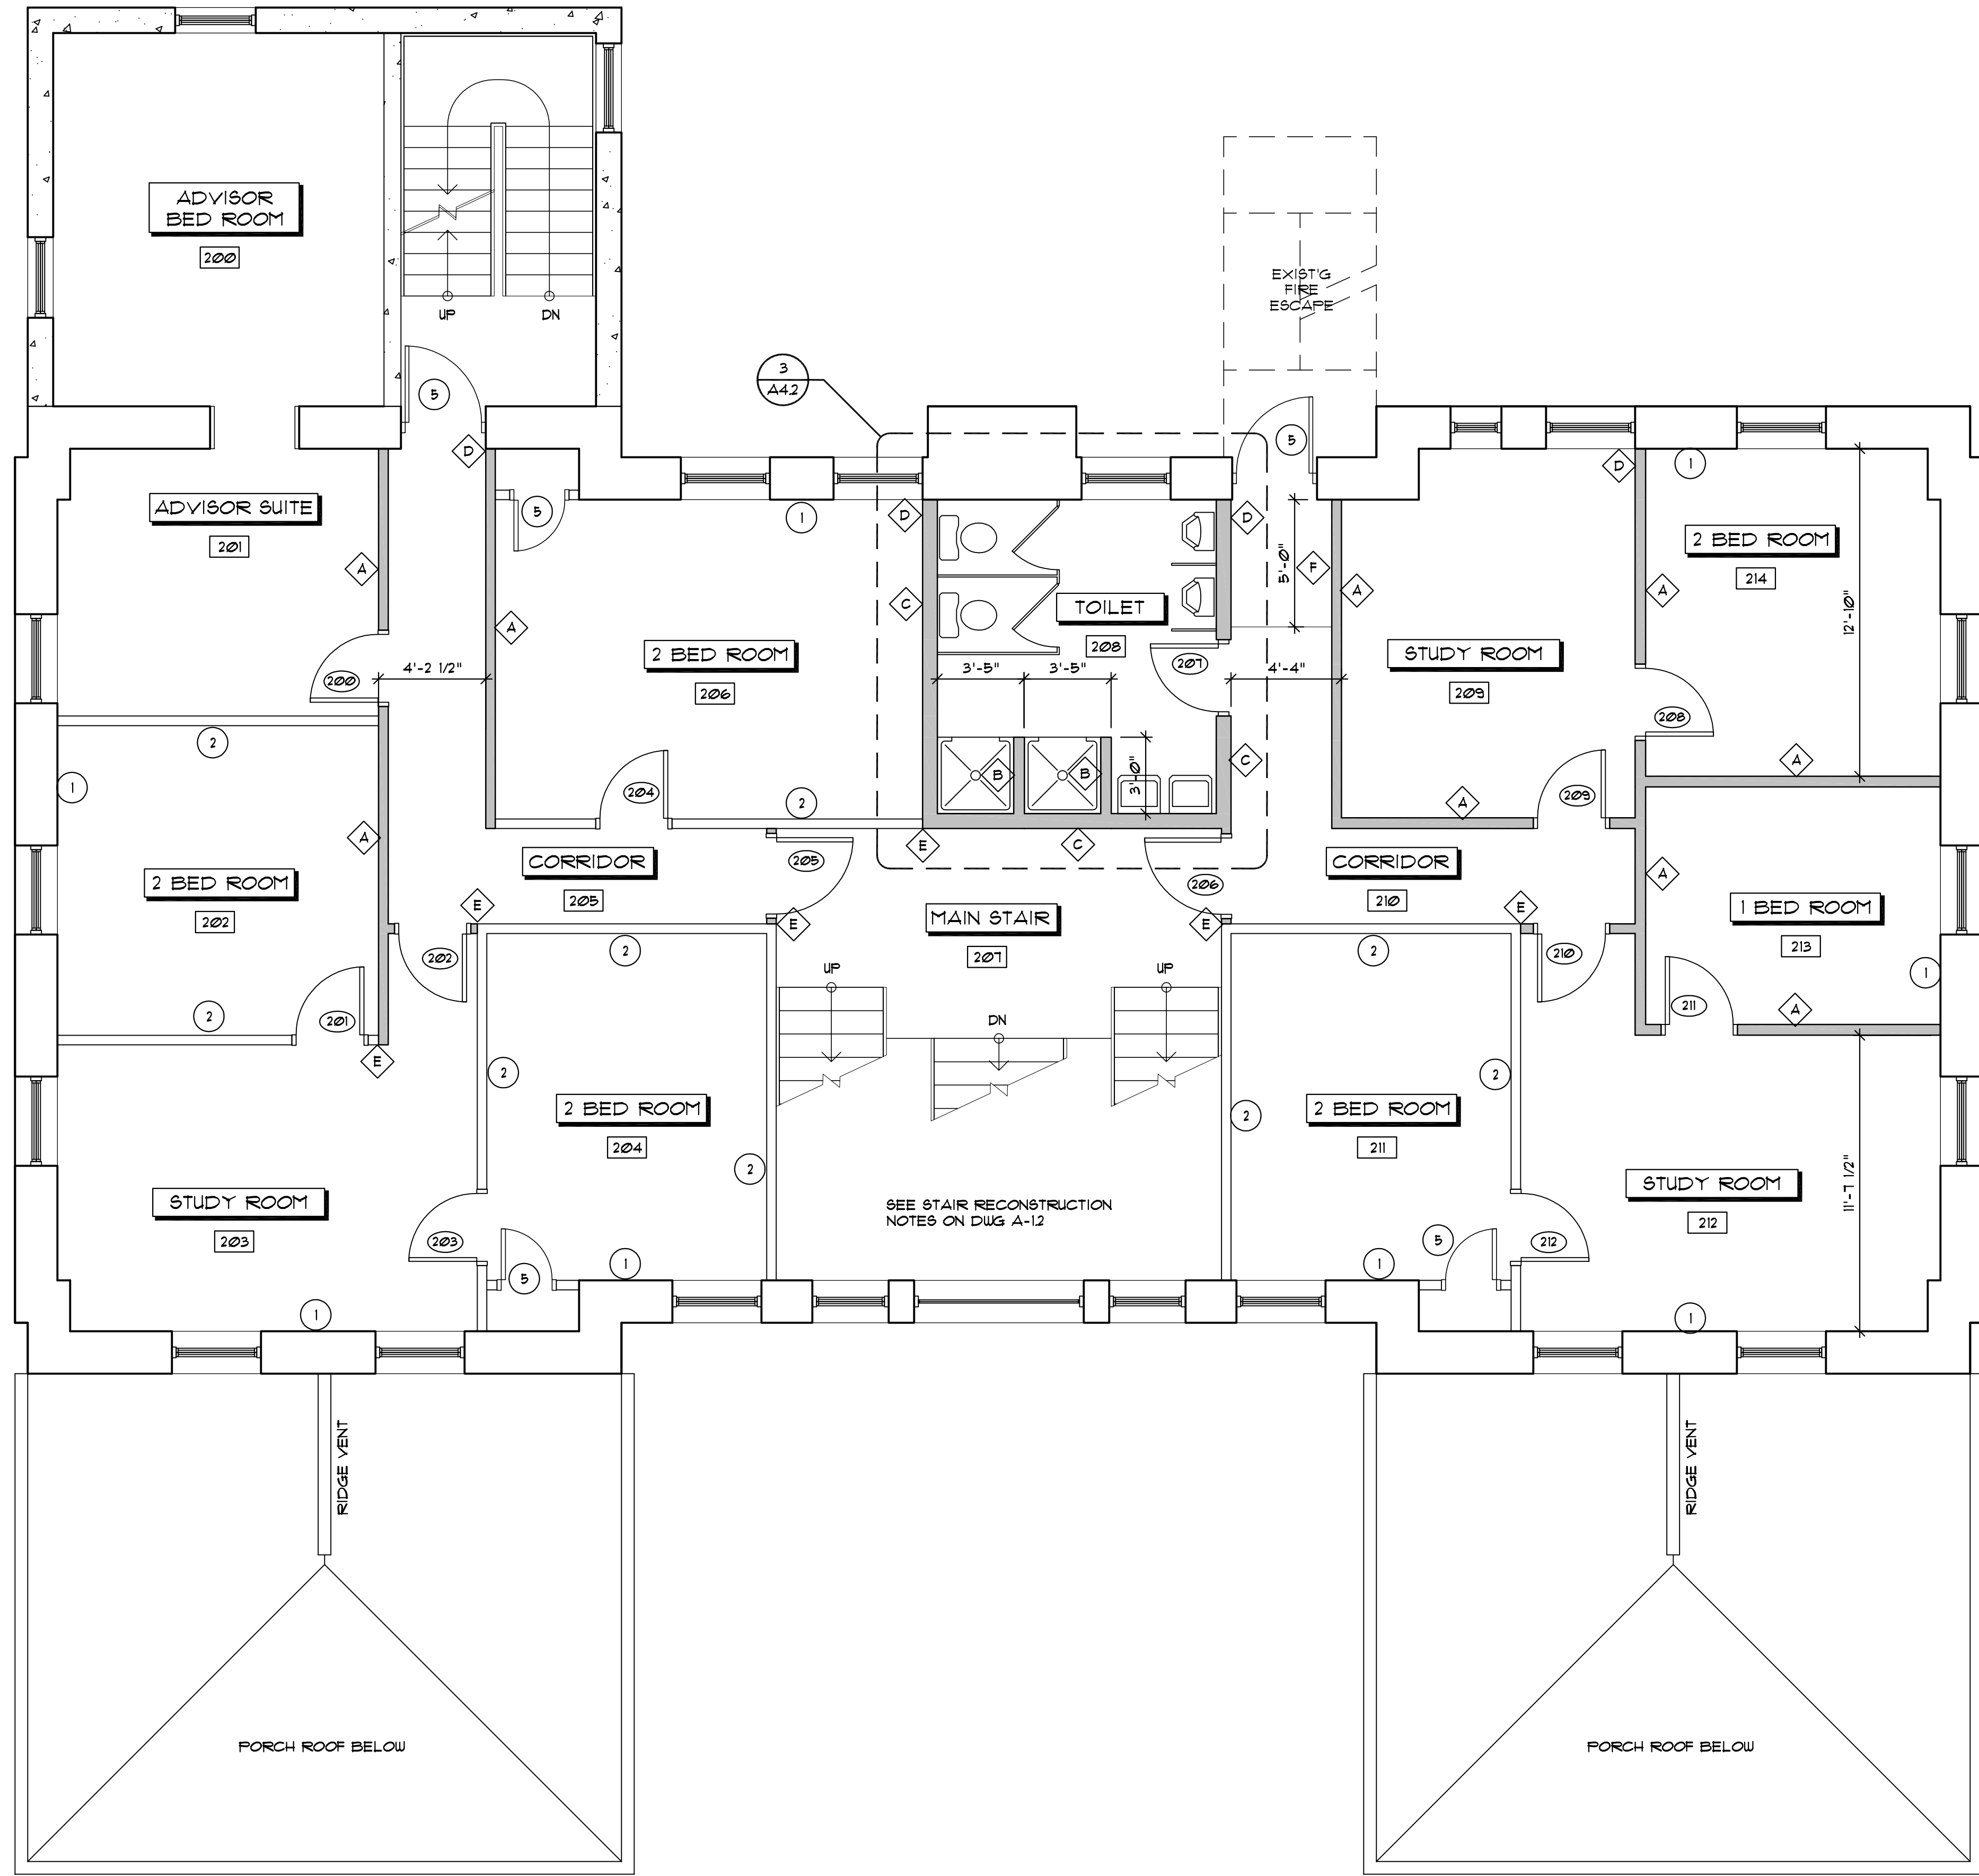


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SECOND FLOOR PLAN


SCALE: 1/4" = 1'-0"

GENERAL CONSTRUCTION NOTES:

1. INSTALL R-13 FIBERGLASS BATT INSULATION IN EXTERIOR WALLS AND INSTALL 5/8" GWB TO INTERIOR SIDE.
2. INSTALL 5/8" GWB TO BOTH SIDES OF EXISTING INTERIOR STUD WALLS.
3. INSTALL 1/2" GWB ON CEILING.
4. ALL INTERIOR DOORS ARE TO BE MIN. 1 3/8" THICK SOLID CORE DOORS.
5. REPLACE EXISTING DOORS AND/OR HARDWARE IF DEFECTIVE.

CONSTRUCTION NOTES:

- A. NEW 2x4" STUDS @ 16" O.C. W/ 5/8" GWB BOTH SIDES, INSTALL SOUND ATTENUATION BLANKETS AT OWNER'S OPTION.
- B. NEW 2x4" STUDS @ 16" O.C. W/ 5/8" MOISTURE RESISTANT GWB BOTH SIDES.
- C. NEW 2x6" STUDS @ 16" O.C. W/ 5/8" GWB ON DRY SIDE AND 5/8" MOISTURE RESISTANT GWB ON WET SIDE. INSTALL SOUND ATTENUATION BLANKETS.
- D. ALIGN NEW WALL WITH FACE OF OPENING.
- E. ALIGN NEW WALL WITH EXISTING WALL.
- F. RAMP FLOOR UP TO EXISTING DOOR SILL. SEE ALTERNATE PLAN BELOW SHOULD TOILET FLOOR NEED TO BE RAISED TO ACCOMMODATE PLUMBING.


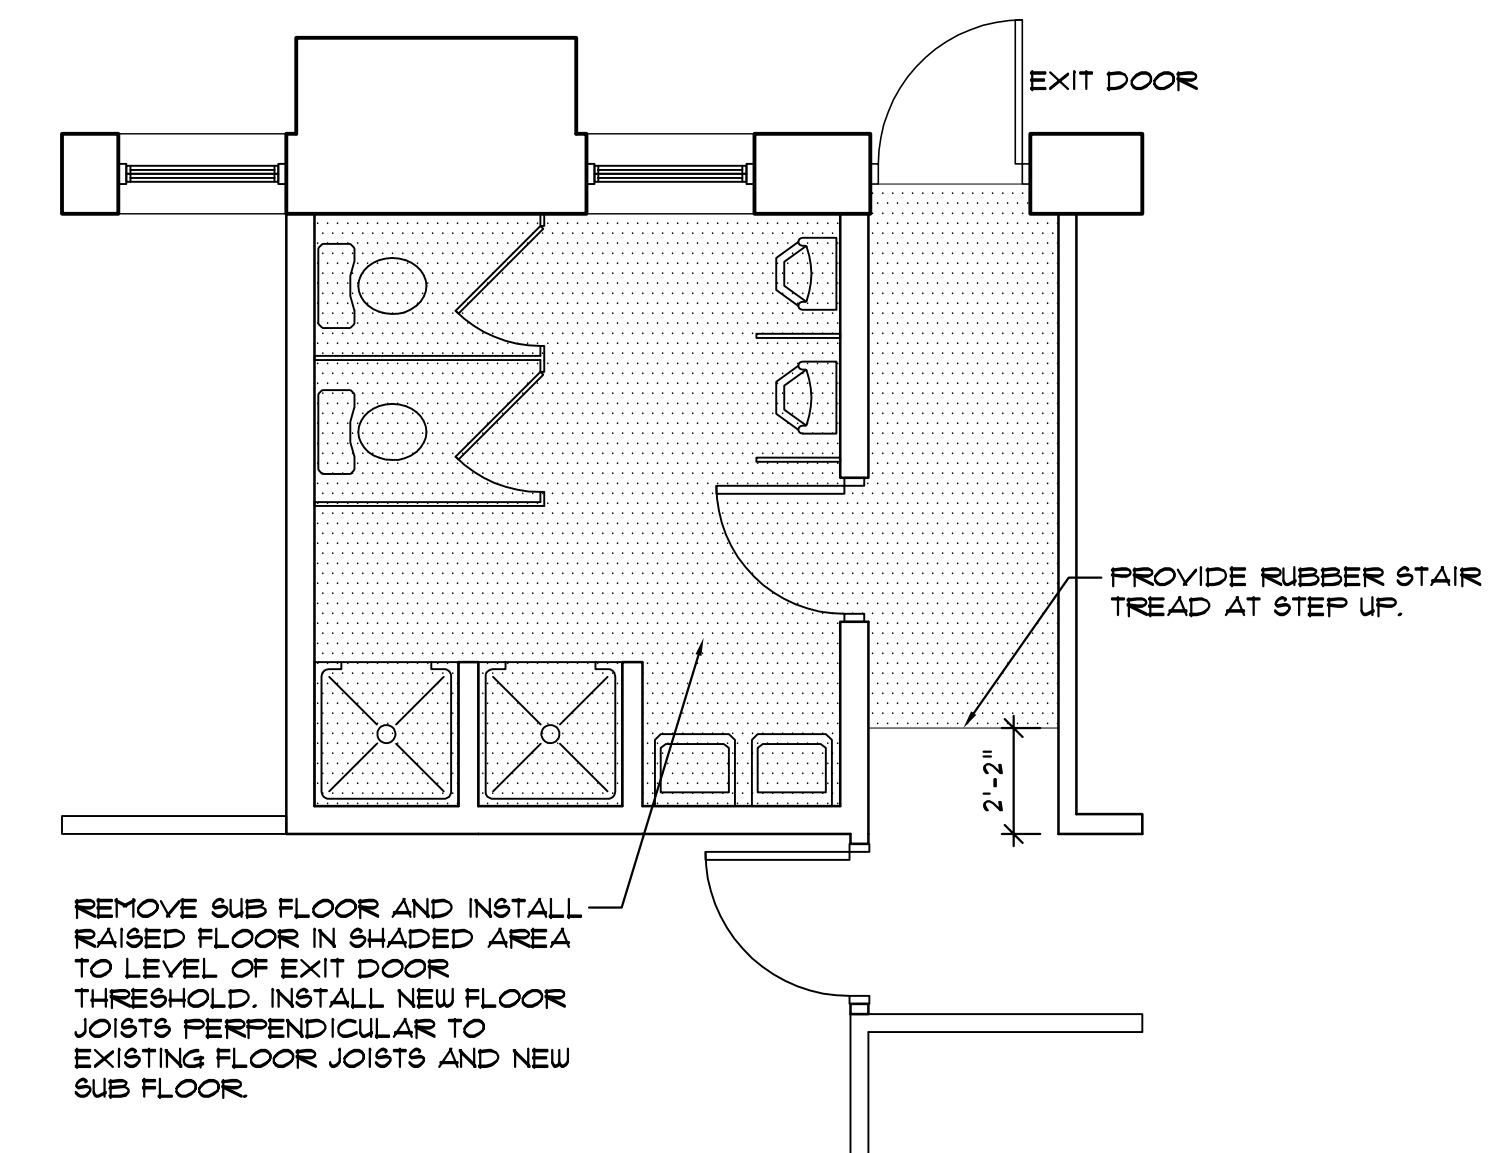


ALT. FLOOR LAYOUT

SCALE: 1/4" = 1'-0"

DRAWING NOTES

1. ALL DIMENSIONS ARE TO FACE OF WOOD STUD, OR TO CENTERLINE OF WOOD STUD UNO.
2. ALL STUDS - #2 KILN DRIED S.P.F. WOOD STUDS UNLESS NOTED OTHERWISE.

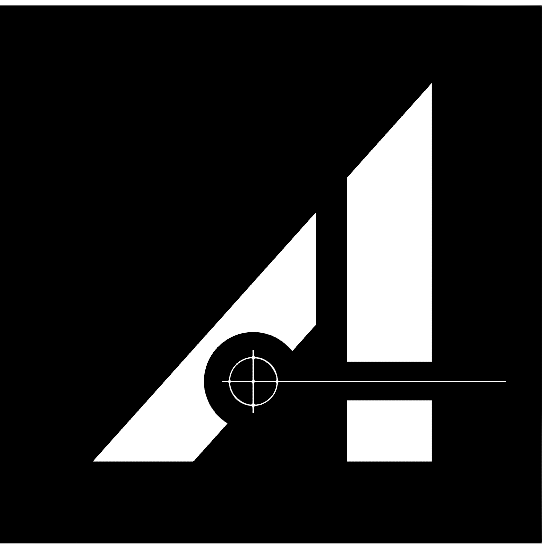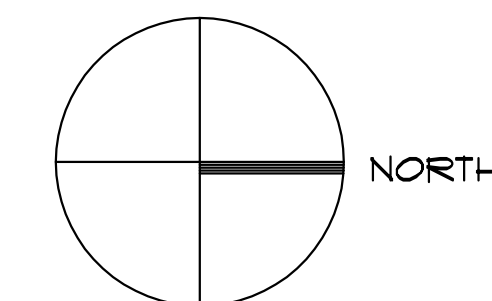

W. BARRY AGNEW ARCHITECT, INC. 121 MANLY STREET, GREENVILLE, SC 29601 864-242-2514

PHI KAPPA PSI FRATERNITY

LAFAYETTE COLLEGE EASTON, PENNSYLVANIA

DRAWN BY:	EMK
CHECKED:	FJR
SCALE:	AS NOTED
JOB NUMBER:	0618
REVISIONS:	
APPROVAL:	4/12/06
OWNER REVIEW:	4/24/06
FINAL REVIEW:	5/22/06

CONSTRUCTION: -

DESCRIPTION
SECOND FLOOR PLAN

SHEET

A = 1.3

OF SHEETS